

LARGE SCALE MAIN LEVEL PLUMBING DEMO FLOOR PLAN NORTH SCALE: 1/4" = 1'-0"

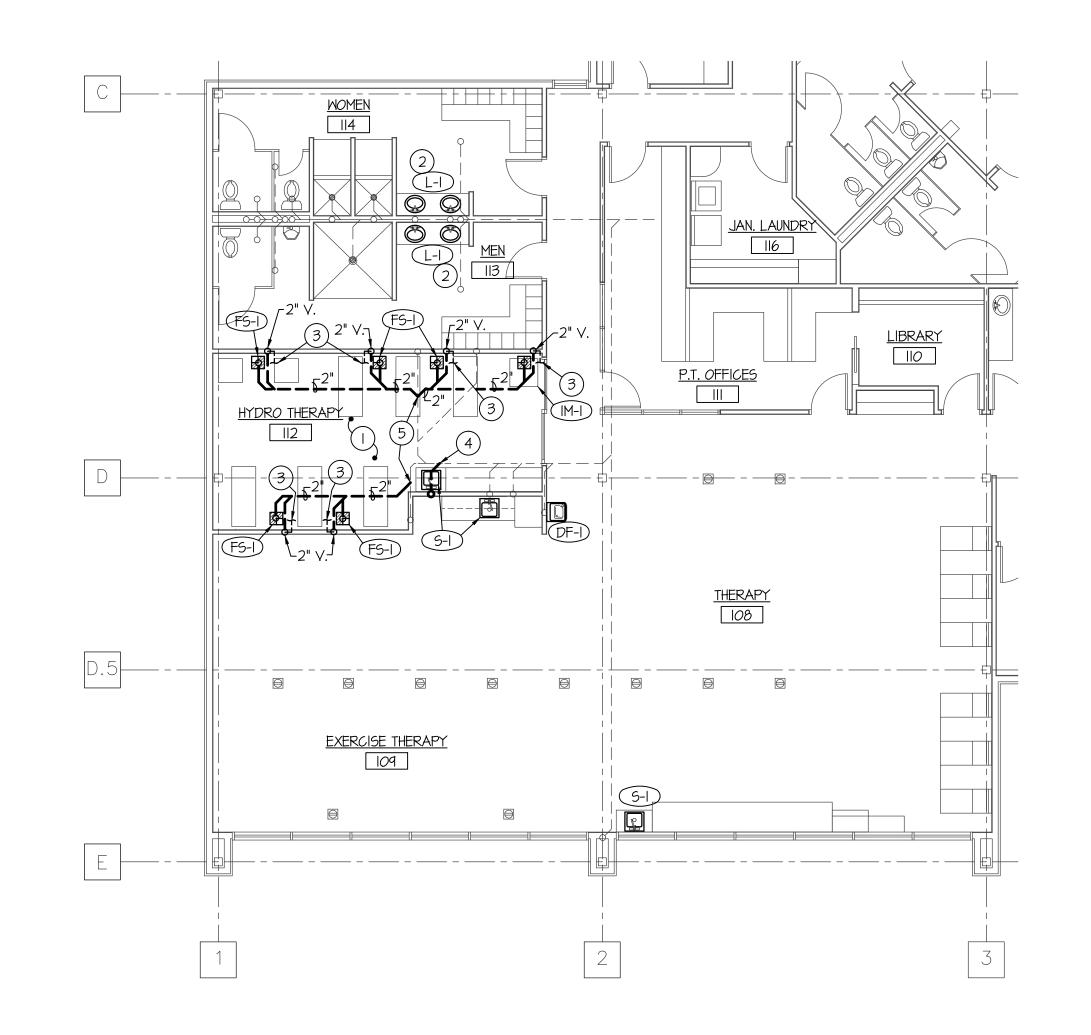




THIS TYPE (COLD EXPANSION) OF FITTING REQUIRES THAT THE PEX PIPING, WITH REIFORCING PEX RING PLACED OVER THE END OF THE END OF THE PIPE, IS EXPANDED BEFORE THE FITTING IS INSERTED INTO THE PIPE END. THE EXPANDED PIPE END IS ALLOWED TO RETRACT ONTO THE FITTING TO FORM THE SEAL. THE MEMORY OF THE PIPE ALLOWS IT TO TIGHTEN OVER THE FITTING. AN EXPANDER TOOL IS REQUIRED TO EXPAND THE PIPE AND THE PEX RING TOGETHER.

ALL JOINTS (TEES. ELBOWS, COUPLINGS, ETC.) ARE JOINTED SIMILARLY.

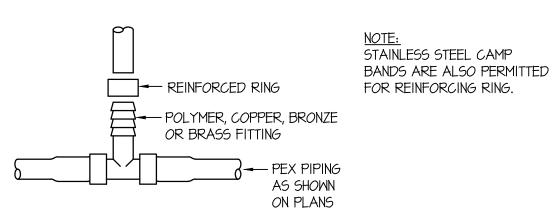

PEX PIPE FITTING DETAILS

NO SCALE

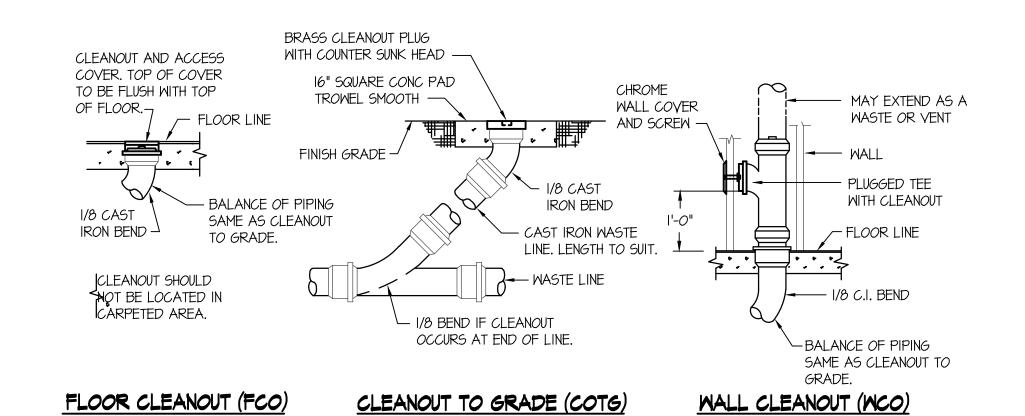


CLEAN OUT DETAILS


NO SCALE

FIXTURE SCHEDULE					
SYM.	DESCRIPTION	НОТ	COLD	WASTE	VENT
DF-I)	DRINKING FOUNTAIN - ELKAY MODEL LZSTL8WSLK WITH BOTTLE FILLER STATION & FILTER FRONT PUSH BAR OPERATORS, I/2" STOP, I-I/2" P-TRAP AND FLEX-GUARD SAFETY BUBBLER VALVE.		1/2"	I-I/2"	I-I/2"
(F5-I)	FLOOR SINK - ZURN Z-1900-KC WITH WHITE ENAMEL FINISH, DOME STRAINER AND 2" DEEP SEAL P-TRAP. PROVIDE 3/4 GRATE OVER SINK.			2"	2"
(F-I)	WALL MOUNTED FAUCET - KOHLER MODEL K-8928 FAUCET WITH VACUUM BREAKER AND BUCKET HANDLE HOLDER.	1/2"	1/2"		
	LAVATORY - REINSTALL EXISTING LAVATORY IN NEW COUNTERTOP AND CONNECT TO EXISTING WASTE, WATER AND VENT PIPING AS REQUIRED. INSTALL EXISTING INSULATING JACKET ON HW LINE AND DRAIN AND PROVIDE NEW STOPS AND SUPPLIES.	1/2"	1/2"	I-I/2"	I-I/2"
(5-1)	<u>SINK</u> - REINSTALL EXISTING SINK IN NEW COUNTERTOP AND CONNECT TO EXISTING WASTE, WATER AND VENT PIPING AS REQUIRED. PROVIDE NEW STOPS AND SUPPLIES.	1/2"	1/2"	I-I/2"	I-I/2"
(M-I)	ICE MACHINE - TO BE SUPPLIED BY THE OWNER, PLUMBING CONTRACTOR TO ROUGH-IN I/2" CW LINE WITH BALL TYPE SHUT-OFF VALVE AND 3/8" REDUCER. ROUGH-IN AND CONNECT 3/4" DRAIN LINE FROM MACHINE TO FLOOR SINK WITH I" AIR GAP.		1/2"	3/4" TO (F5-I)	-

PLAN NOTES:

- SAWCUT EXISTING SLAB AS REQUIRED FOR NEW FLOOR SINKS.
- 2) REINSTALL EXISTING LAVATORY IN NEW COUNTERTOP AND RECONNECT TO EXISTING WASTE, WATER AND VENT PIPING AS REQUIRED. PROVIDE NEW BALL STOPS AND SUPPLIES.
- 3) CONNECT NEW 2" VENT FROM FLOOR SINK TO NEAREST 2" OR LARGER VENT PIPING LOCATED ABOVE CEILING. FIELD VERIFY EXACT LOCATION OF EXISTING PIPING.
- 4) SAWCUT EXISTING SLAB AS REQUIRED TO INSTALL NEW 2" WASTE LINE FROM RELOCATED SINK AND CONNECT TO EXISTING WASTE MAIN UNDERSLAB.
- 5) CONNECT NEW 2" WASTE LINE TO EXISTING 2" OR LARGER WASTE LINE UNDERFLOOR. FIELD VERIFY LOCATION OF EXISTING WASTE LINE.

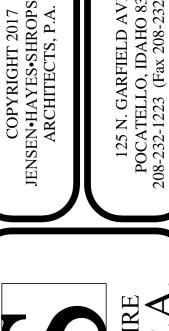

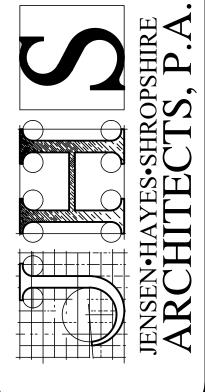

SPORTS MEDICINE CENTER REMODEL AT IDAHO STATE UNIVERSITY MECHANICA

ORIGINAL DRAWING SIGNED BY: DWAYNE SUDWEEKS DATE ORIGINAL SIGNED: JULY 31, 2019

PLUMBING LEGEND

VTR

COTG

c-----

0----

DESCRIPTION

VENT THRU ROOF

MALL CLEANOUT

CLEANOUT TO GRADE

- BALL TYPE ISOLATION VALVE

DOMESTIC COLD WATER PIPING

HOT WATER RECIRC. PIPING

CONDENSATE DRAIN PIPING

- ROOF OVERFLOW DRAIN PIPING

- ROOF DRAIN PIPING

CLEANOUT


PIPE DROP

PIPE RISE

- GAS PIPING

---- SOIL OR WASTE PIPING

----- VENT LINE PIPING

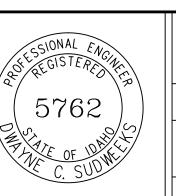

ORIGINAL ON FILE AT ENGINEERED SYSTEMS ASSOCIATES 315 WEST CENTER, POCATELLO, IDAHO 83204 REVISIONS: Engineered **Systems Associates** DRAWING NO. 1355 EAST CENTER POCATELLO, IDAHO 83201 (208) 233-0501 (208) 233–0529 EMAIL: esa@engsystems.cor ESA JOB NUMBER: 19048